

CHABAD CENTER EXPANSION

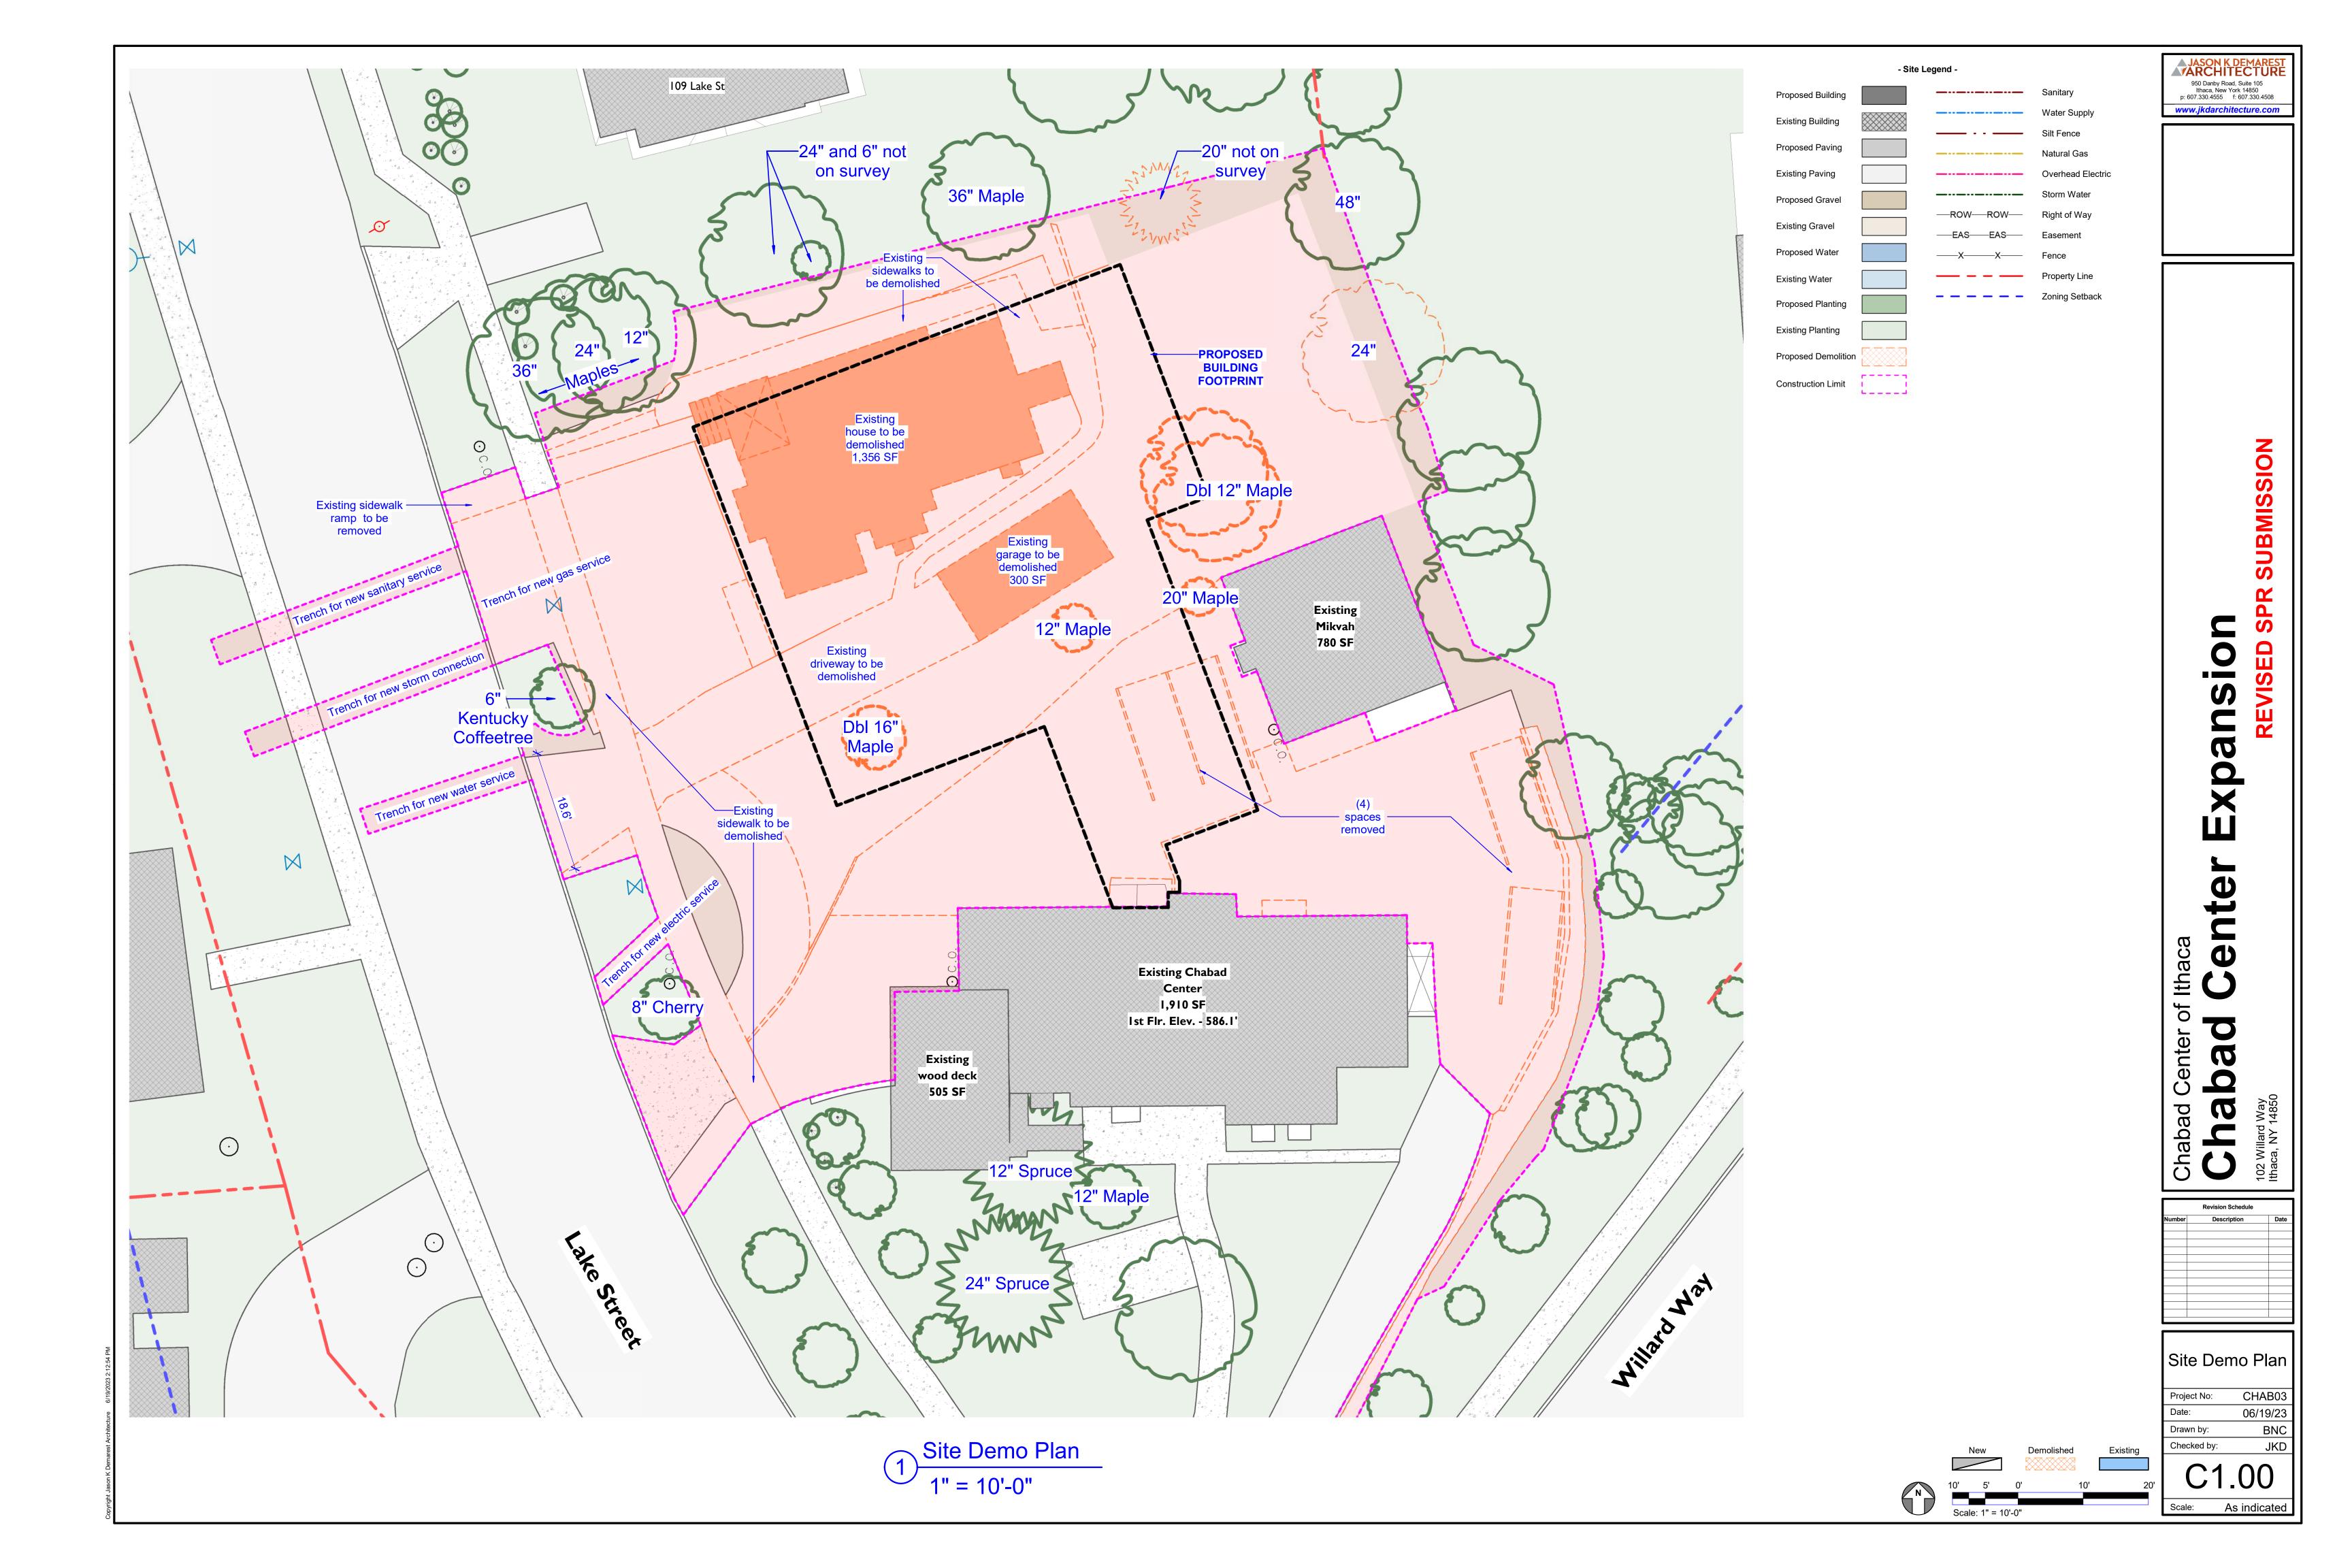


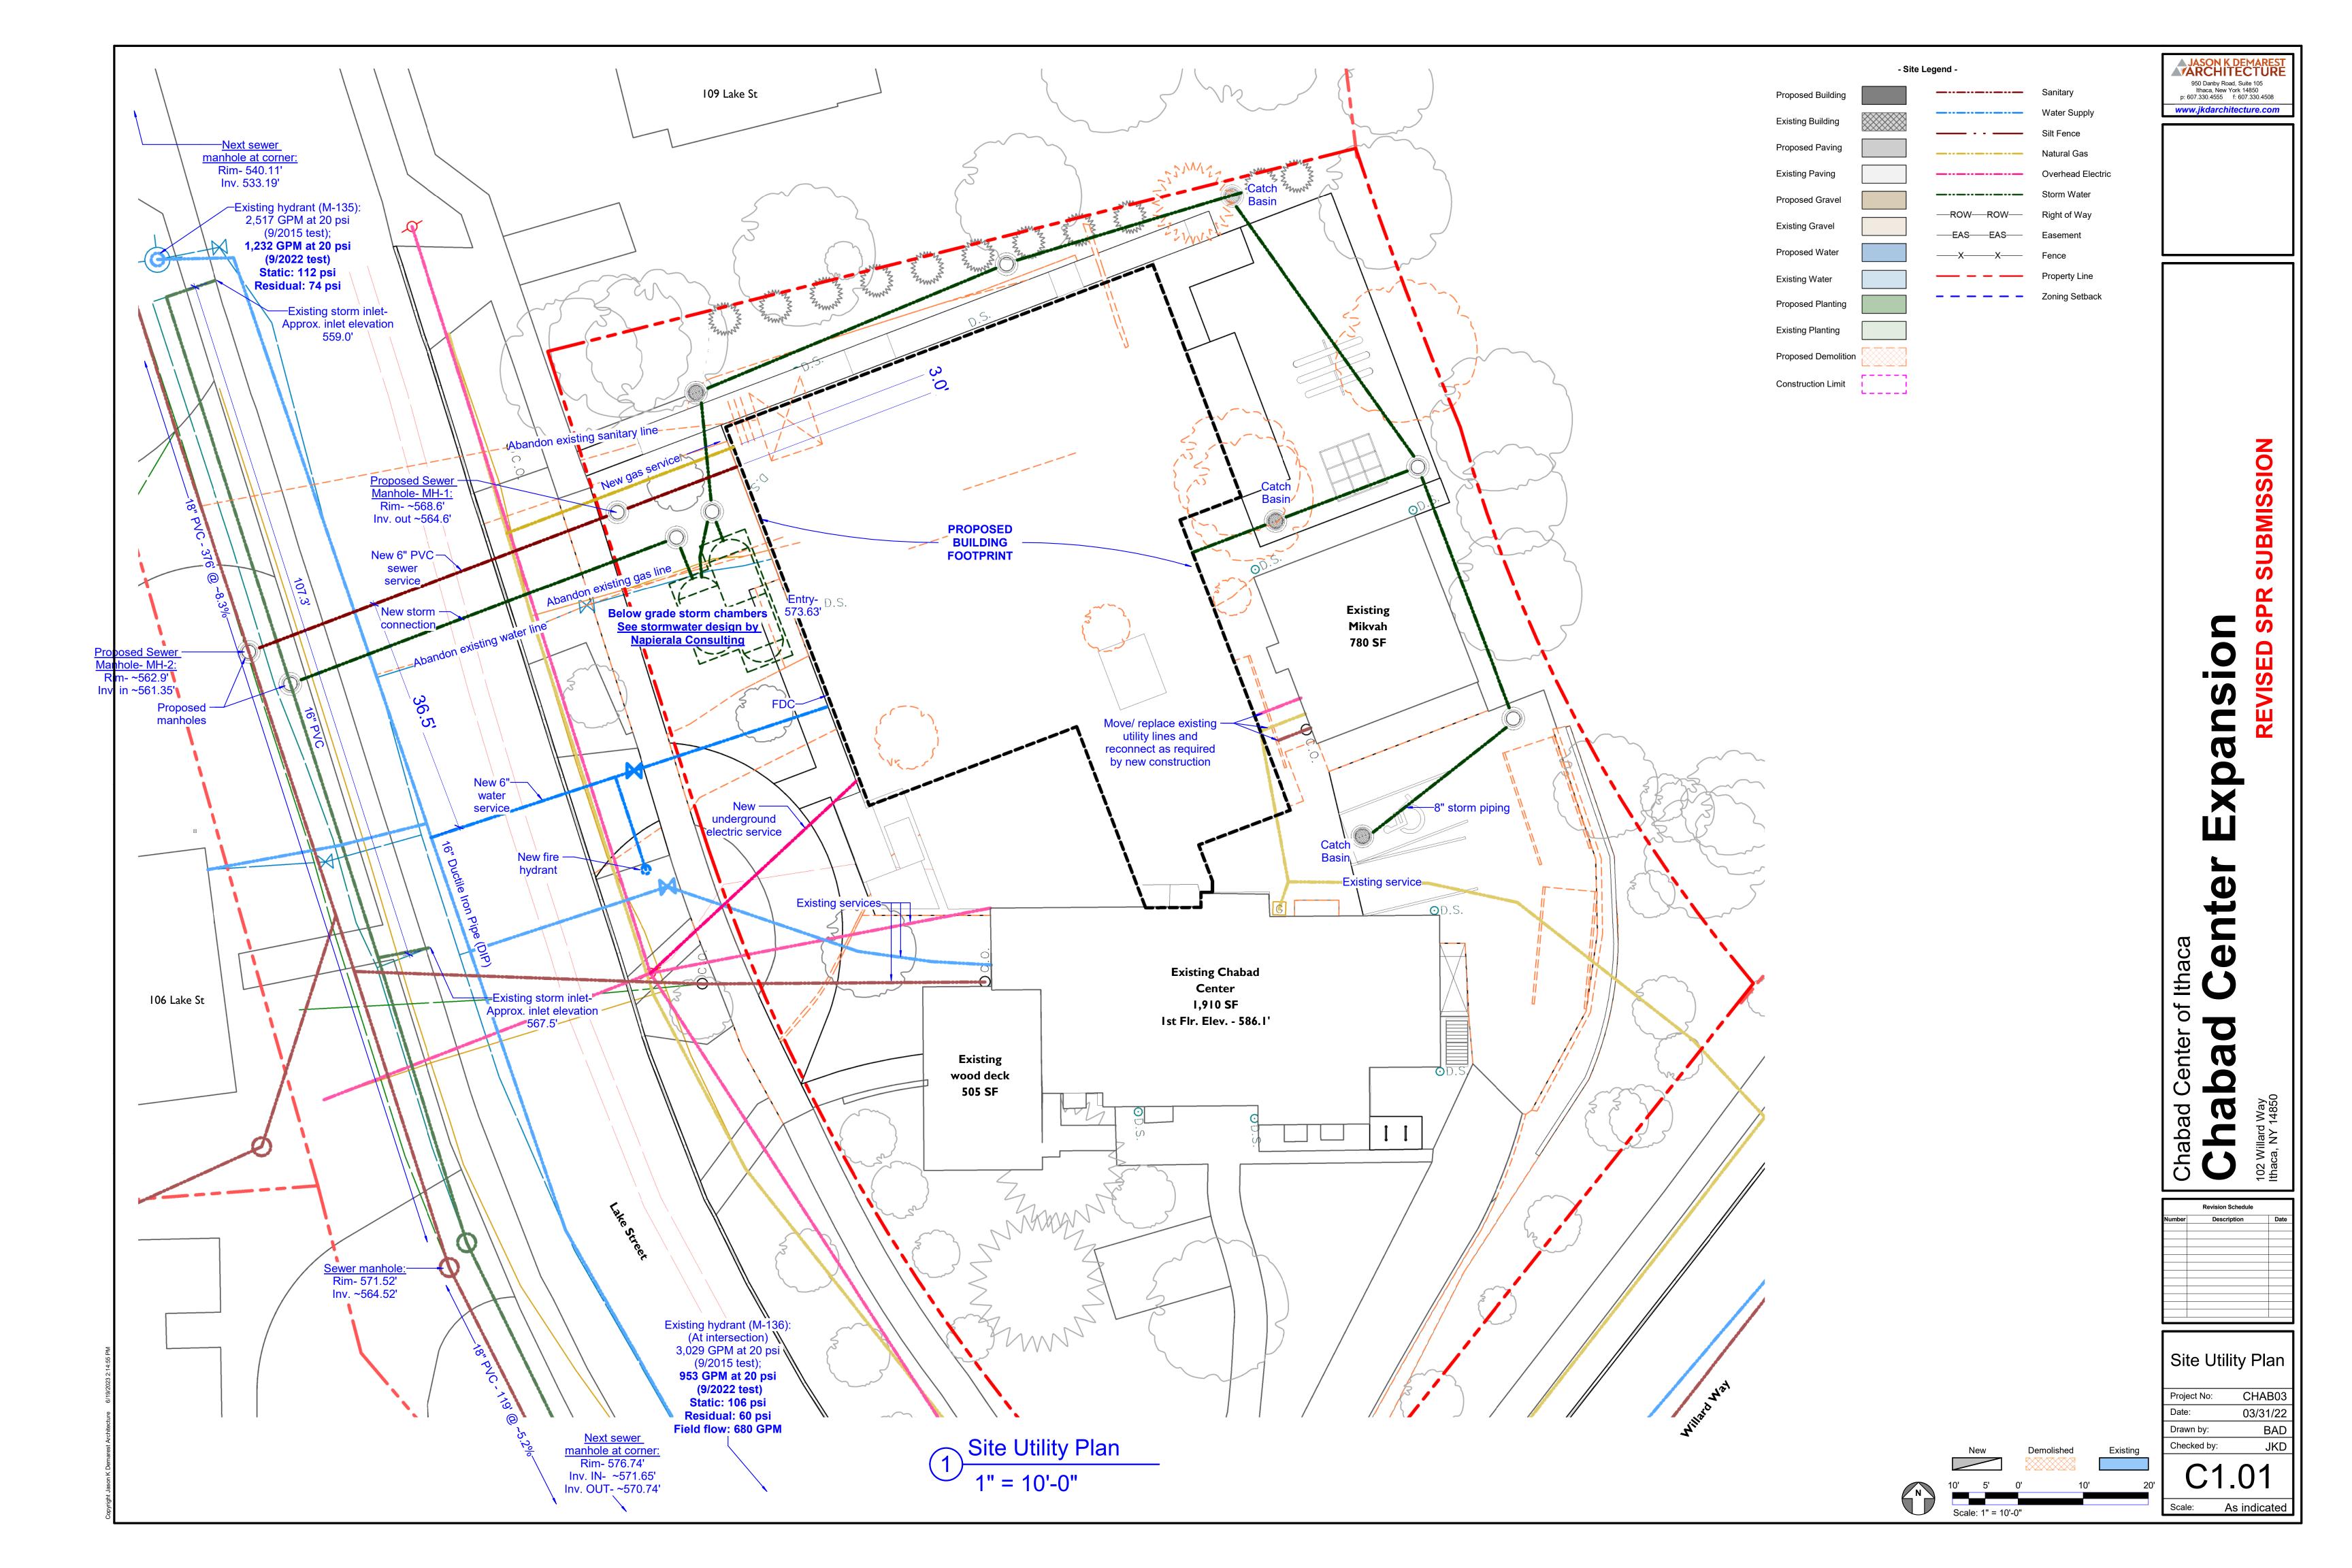





CIRCULAR DRIVE REQUEST:

The circular driveway is being requested to provide a drop off area for the congregation space in the basement and to facilitate the exiting from the one proposed parking space that serves the basement apartment in the existing Chabad House. The driveway also allows for two end-to-end parking spaces. The creation of this drive utilizes the two existing curb cuts and does not eliminate any existing street trees. The slope of the drive is 8% for the north half which is reasonable for passenger vehicles. In contrast adjacent driveways have grades of 20%. This circular drive was previously requested to provide access for trash & recycling pick-up and would have served trucks, but the pick-up was changed during the prior approval process and the circular drive was eliminated. This new proposal has narrowed the drive to 11' wide and reduced the two existing curb cuts in width. Ample plantings have been proposed.

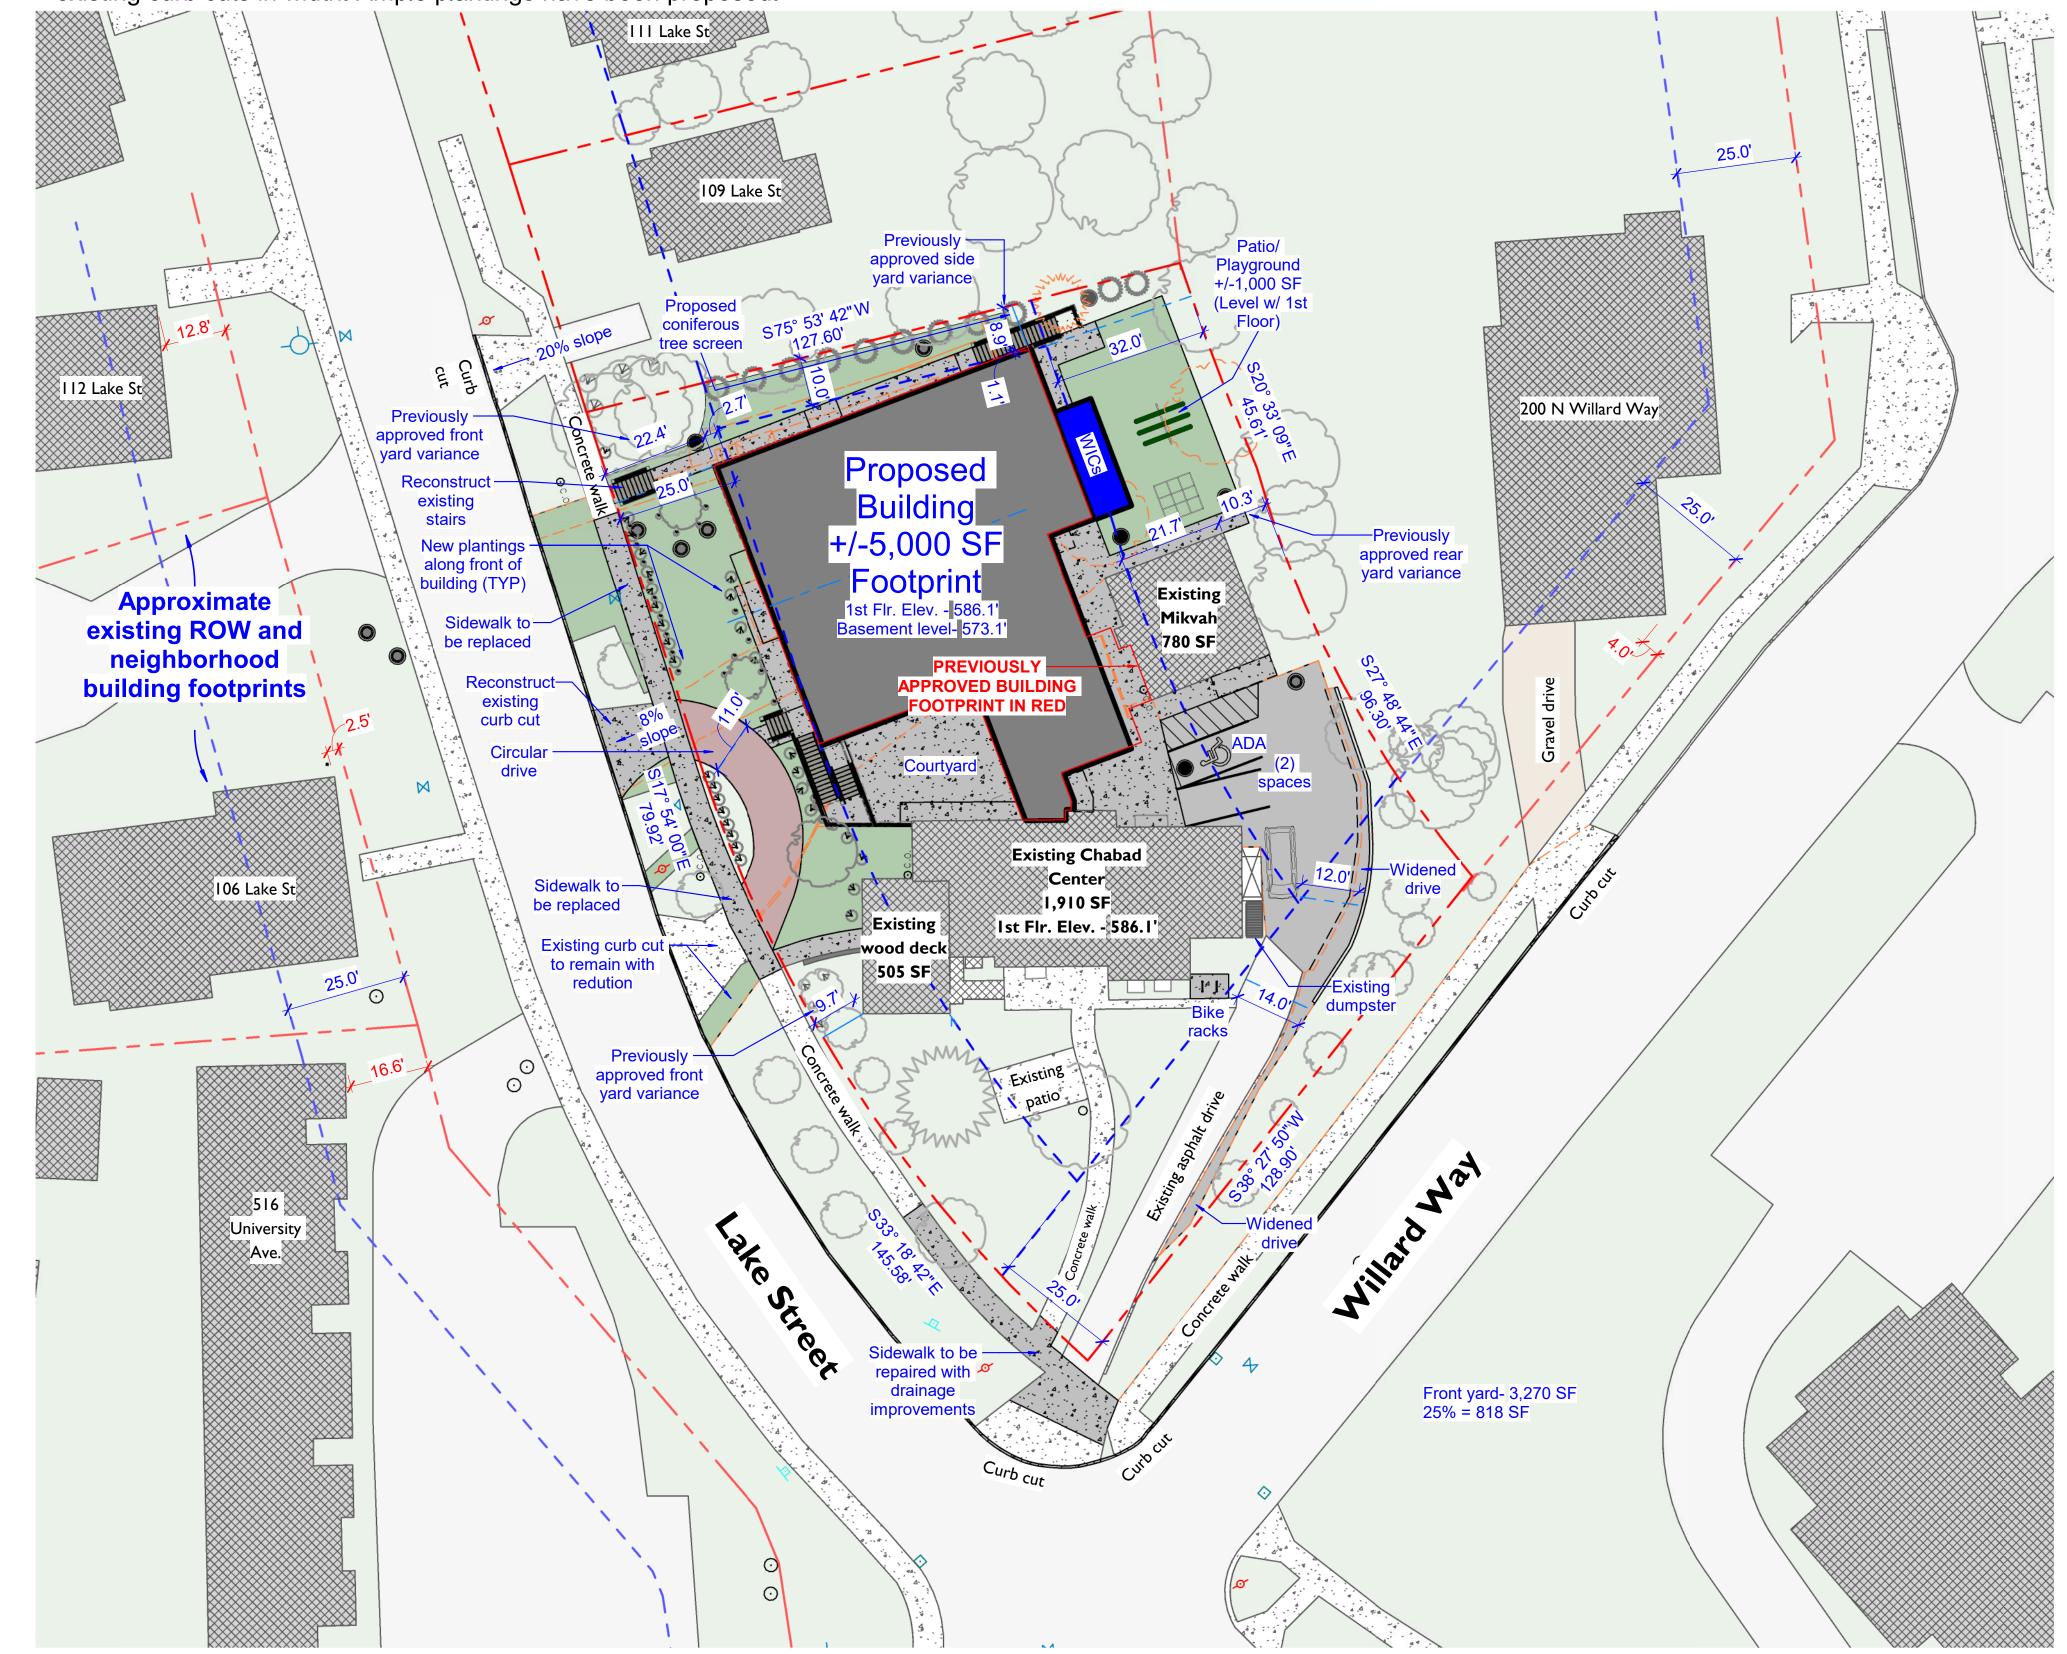

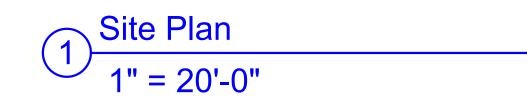

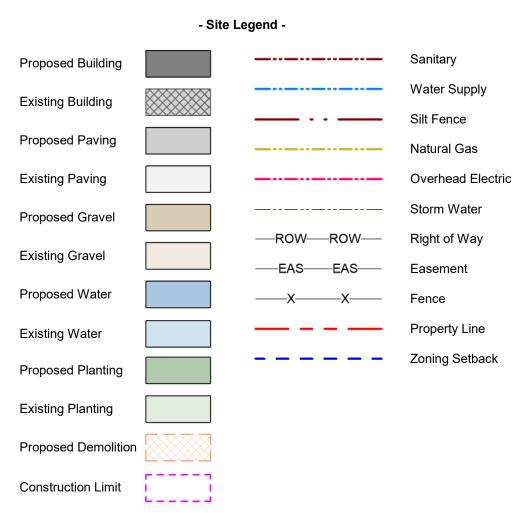

PROJECT UPDATE:

The project is scheduled to break ground in July. Funding is almost complete but some donors felt the parking garage was an unnecessary loss of valuable program space. Since the Chabad functions and activities do not require parking to operate, the proposal here is to remove the garage and add a congregation hall (shul or synagogue). This will allow the shul to be dedicated to its function and also accommodate the full 150 person occupancy during the high holidays a few days per year. The 150 person dining room remains as the primary function on Friday nights and the largest regularly occupied activity. The other smaller rooms throughout the buildings will serve as meeting and classroom space during the week.

LOT AREA:

Combined Lot Area: 23,903 SF

MAX Lot Coverage: 30% (7,171 SF)

Chabad House: 1,910 780 Mikvah: **Existing Deck:**

Existing Total:

Proposed Project: 4,795 + 192 walk-in coolers = 4,987 8,182 **(34.3% VARIANCE GRANTED)** Total:

BUILDING HEIGHT: 35 feet MAX, Actual = 23 feet

YARDS:

See setback lines on site plan (FRONT, SIDE & REAR YARD VARIANCES GRANTED; REAR YARD FOR EXISTING MIKVAH)

DRIVEWAY SLOPE: 8% MAX, Actual = 8%

PARKING:

Parking Spaces Required for Existing Conditions Only

- Basement Apartment (1 per 1 to 3 bedrooms)= 1 space
- Existing meeting room replaced by new facility (Becomes accessory space)

Total = 1 space

Parking Spaces Required for Proposed Only:

• Church (1 per 10 seats)= 15 (150 seats) Total = 15 spaces


TOTAL REQUIRED PARKING SPACES = 16

Actual Parking Spaces = 2 existing to remain (4 exist) + 4 leased offsite spaces = 6

Parking deficiency = 10 spaces

(VARIANCE GRANTED FOR 11 SPACES)

Note: Off-site parking spaces available in 168 space Cornell parking lot across street (University Ave Lot)

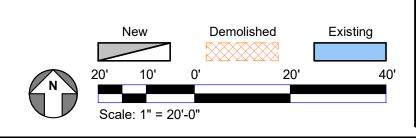

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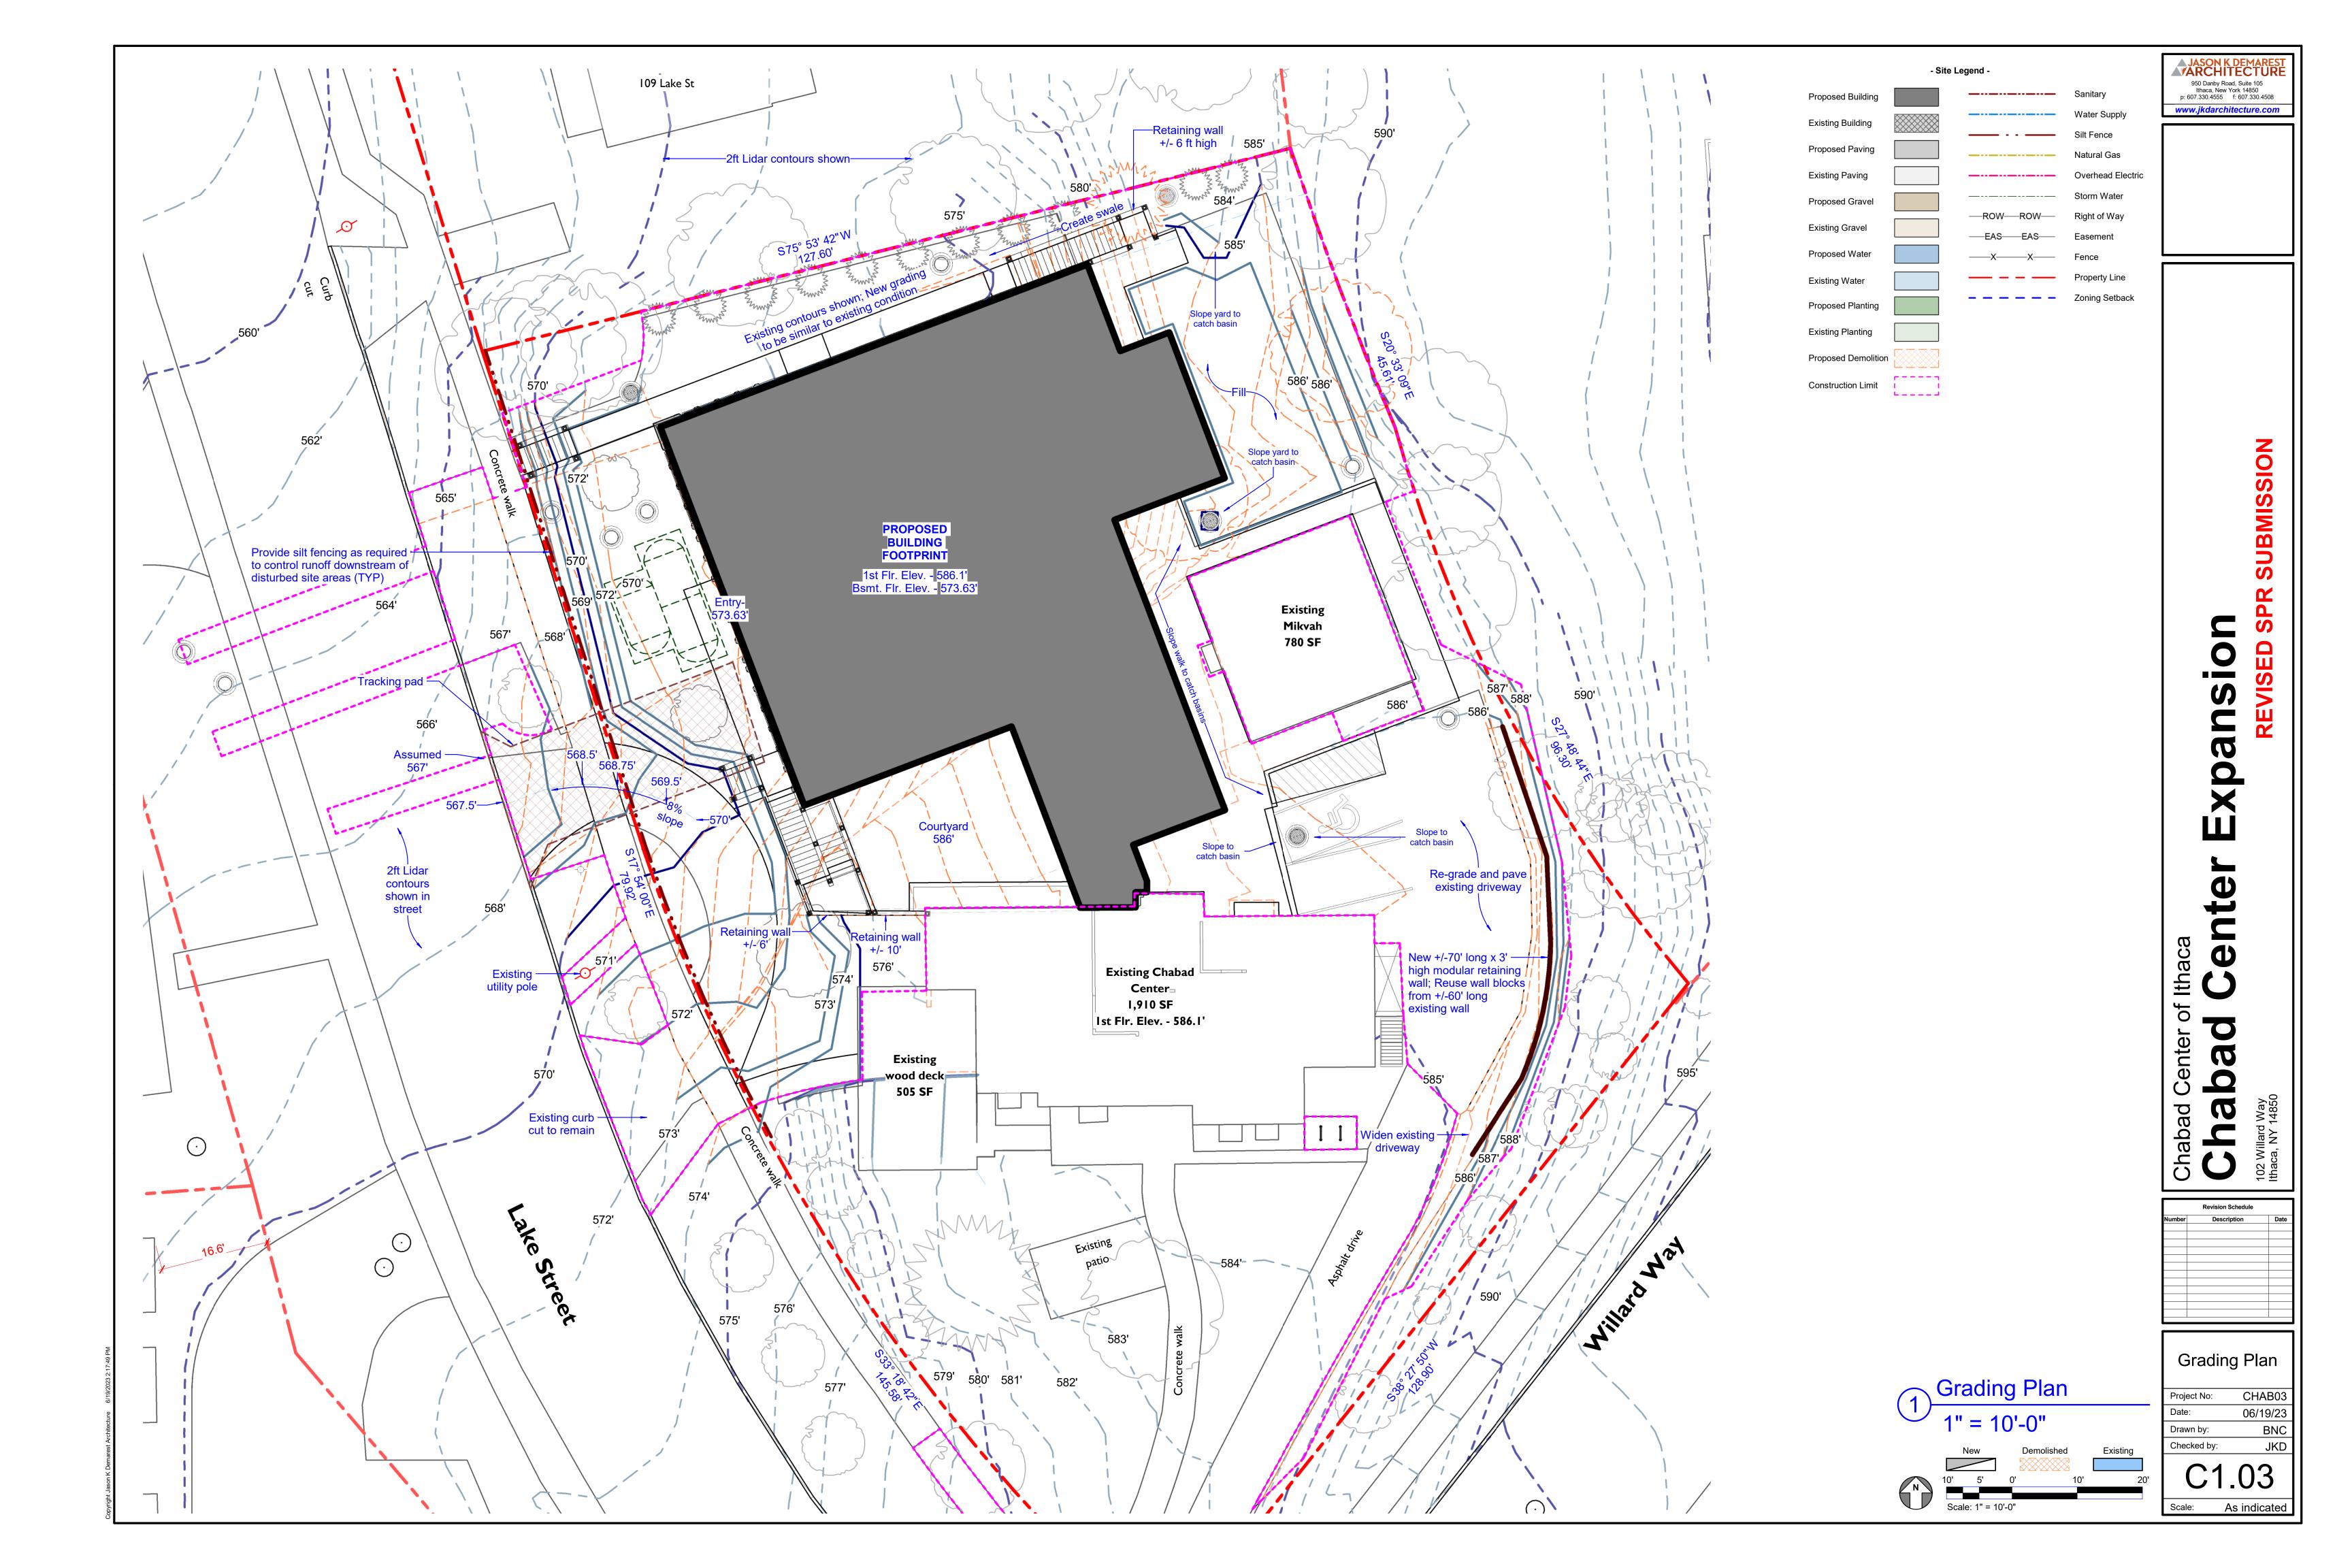
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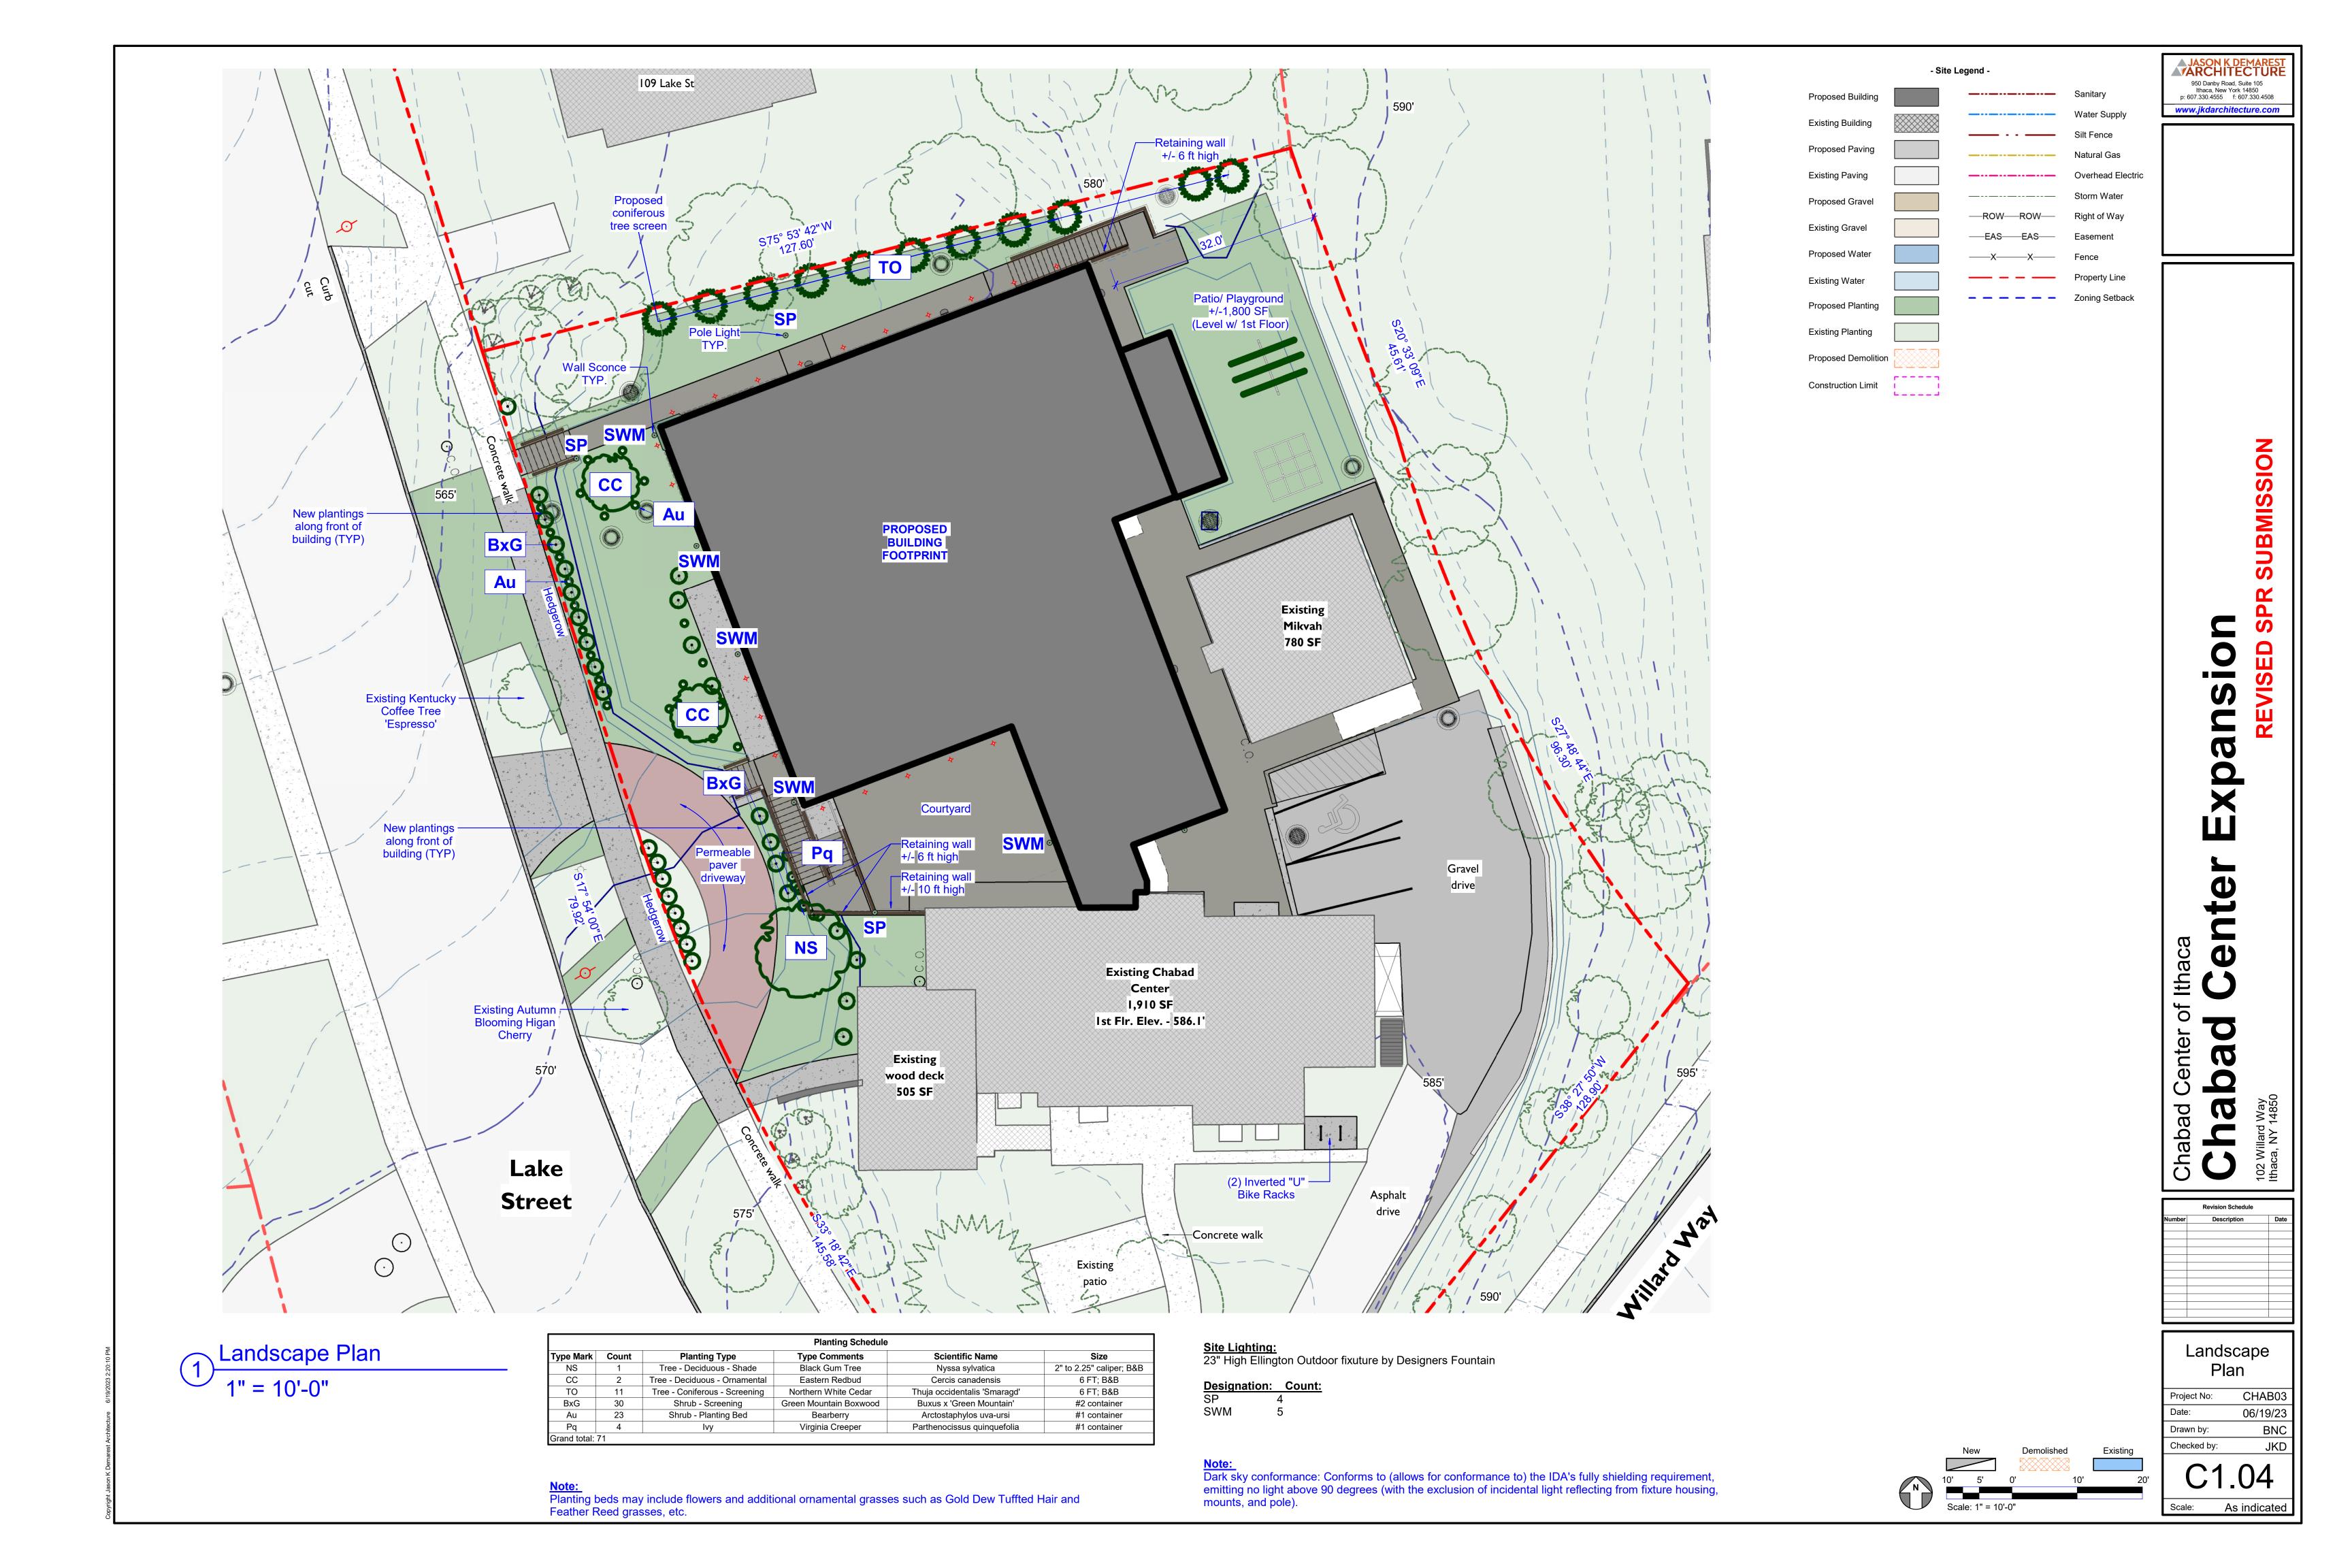
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Site Plan CHAB03 06/19/23 BAD Drawn by:

As indicated





-Plant shall be set at or slightly above the established finish grade so that the top of the root ball is visible —3" mulch. Mulch should not be in contact with tree trunk. Keep mulch Remove any non-biodegradable material from 1/3 of root ball -Grade to saucer in lawn areas Scarify sides and bottom of tree pit to prevent glazing of subgrade- place root ball on unexcavated or CU structural soil to prevent settlement 3 X Rootball Diameter

 Plant shall be set at or slightly Plant at same depth as previously planted in nursery or container.
 Provide compacted base under root ball only to prevent settling. above established finish Do not prune the trees unless directed by the city forester.
 Stake trees only upon approval of city forester. —3" shredded bark mulch. Mulch should not be in contact with tree trunk. Keep mulch weed free Remove any non-biodegradable material from 1/3 of rootball. If container grown, remove entire -Specified planting mix Place root ball on unexcavated or CU structural soil to prevent settlement Bed width varies

Shrub Planting Detail

Tree Planting Detail

Tree, Shrub Protection

Planting bed



Tree Protection

Virginia Creeper (Pq) Scientific name: Parthenocissus quinquefolia Height: varies



Bearberry (Au) Scientific name: Arctostaphylos uva-ursi Height: up to 6" tall




Lilac (Sv) Scientific name: Syringa vulgaris 'Madame Lemoine' Height: 30"+ tall



Green Mountain Boxwood Dwarf (shrubs) (BxG) Scientific name: Buxus x 'Green Mountain' Height: 2ft-4ft

Shade Tree

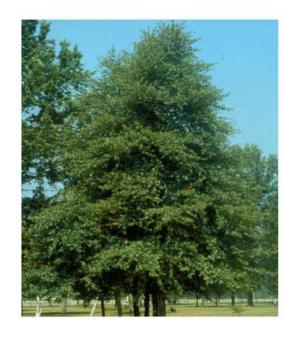

Black Gum Tree (NS) Scientific name: Nyssa Salvatica Height: 50ft +

Screening Tree



Northern White Cedar (TO) Scientific name: Thuja occidentalis Height: 6ft

Ornamental Tree



Eastern Redbud (CC) Scientfic name: Cercis canadensis Height: 20-30ft

Planting Notes:

- 1) Tree plantings shall conform to the requirements/guidelines outlined in the document, "Ithaca's Trees: Master plan, Inventory, & Arboricultural Guidelines for the Public Trees of the City of Ithaca, New York."
- 2) All trees and plants to comply with applicable requirements of ANSI 260.1, "American Standard for Nursery Stock."
 3) No plants or trees shall be located beneath building overhangs.

- 4) Strip and stockpile existing topsoil for reuse.
 5) Prepare shrub beds with 24" MIN depth of planting soil. Prepare tree beds to depth of rootball by 3x the diameter.
 6) All disturbed areas that are not shown as paved or planted bed are to be rock-hounded and seeded as lawn.
- 7) Provide warranty for all planted material.

Outdoor Lighting



Wall mount, Pendant, Pole Light

Designers fountain 23"H Ellington Outdoor Post Lantern Oil Rubbed Bronze

Dark sky compliant: Conforms to (allows for conformance to) the IDA's fully shielding requirement, emitting no light above 90 degrees (with the exclusion of incidental light reflecting from fixture housing, mounts, and pole).

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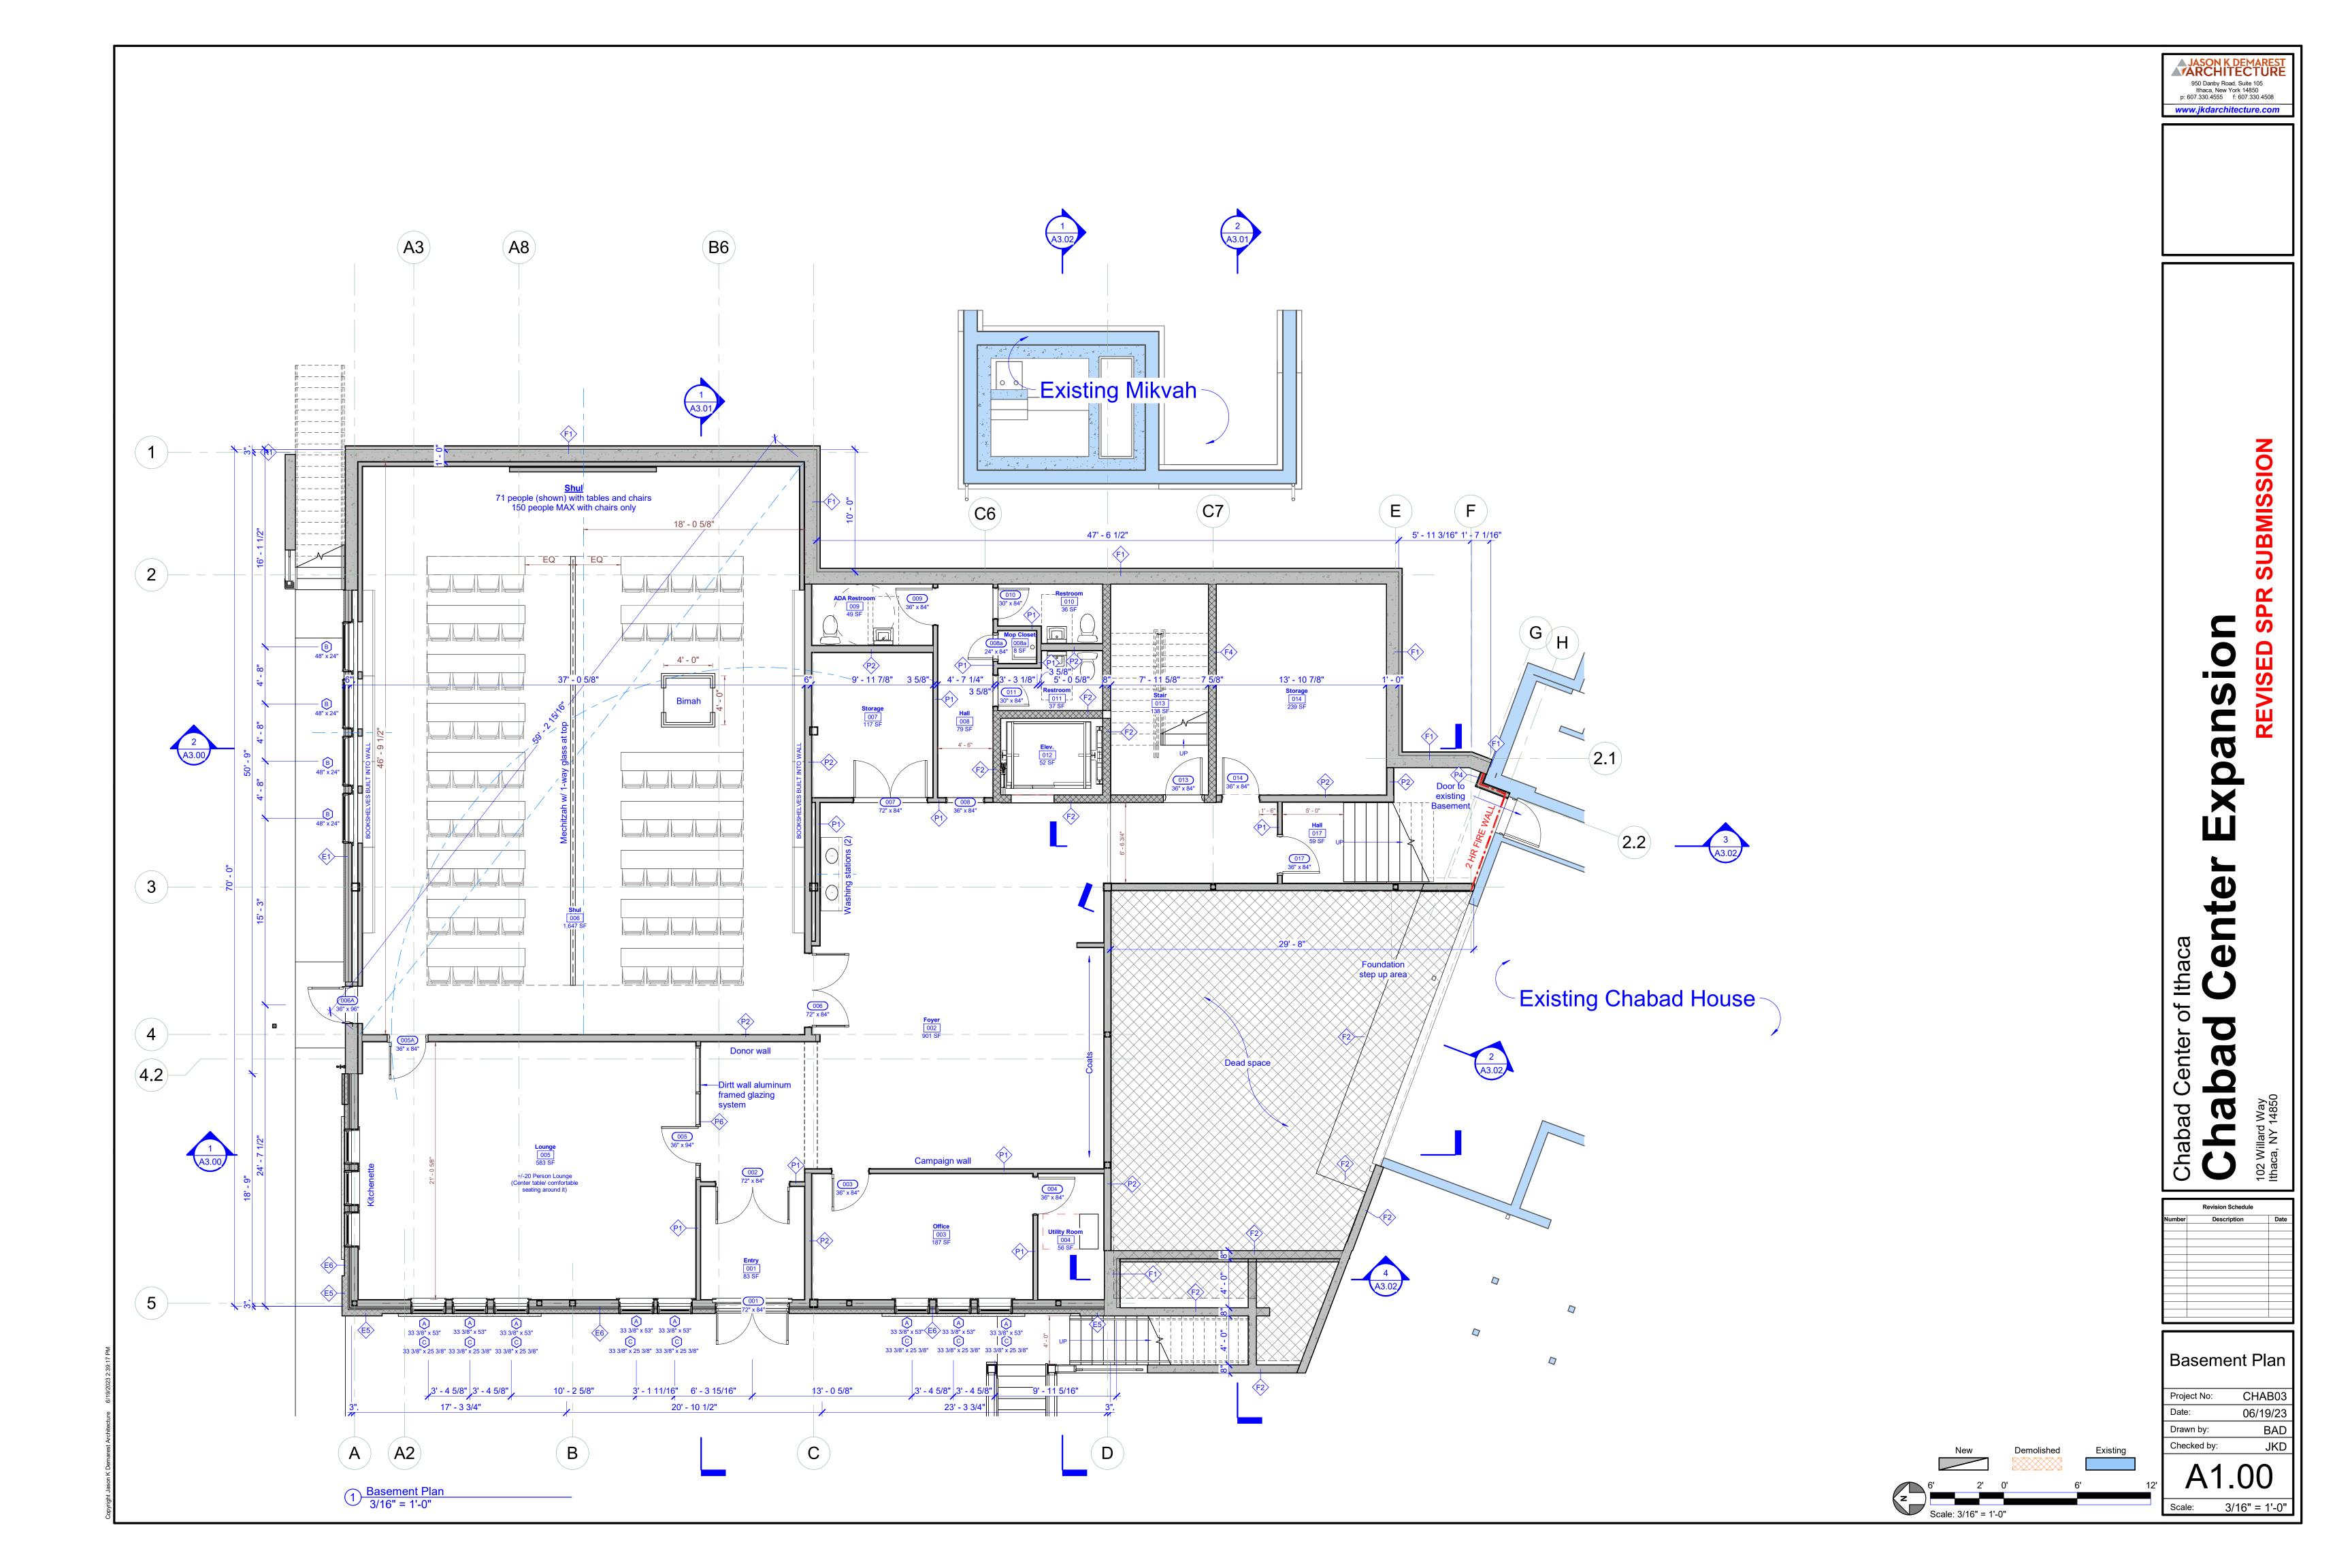
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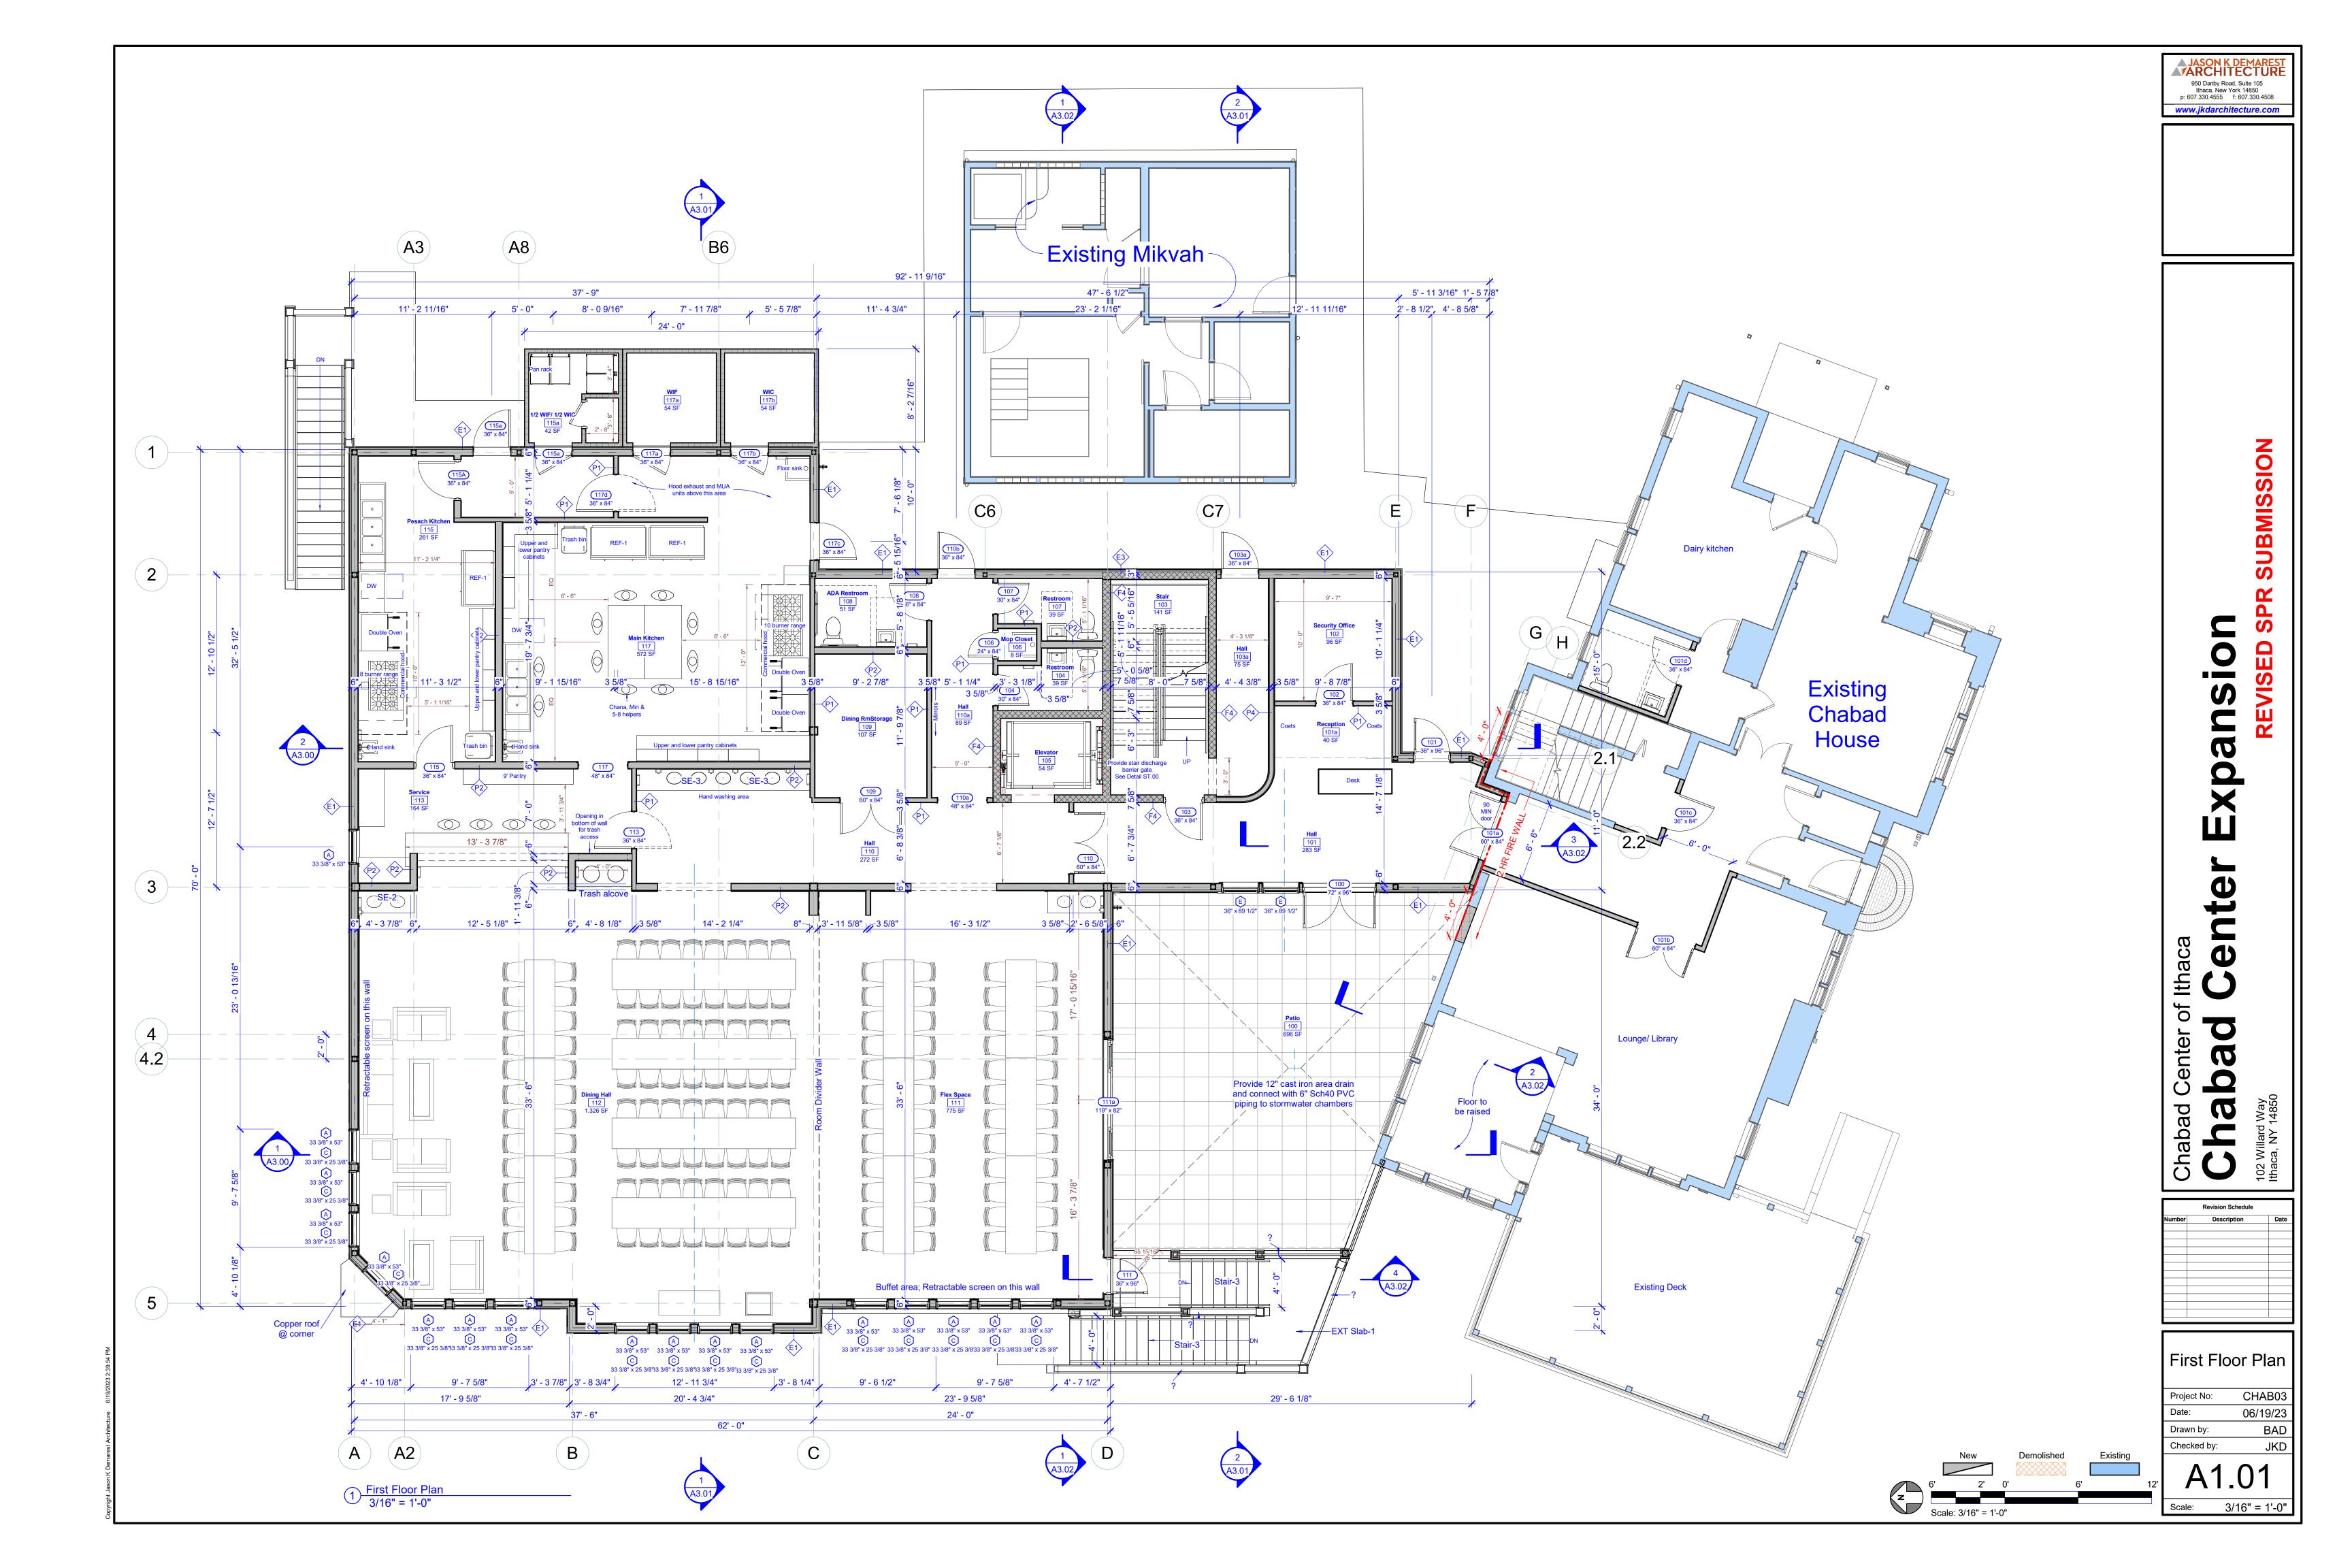
Chabad

Planting & Site Lighting Details CHAB03 Project No: 06/19/23 BNC Drawn by: JKD Checked by: C4.00


As indicated


Scale: 1/2" = 1'-0"







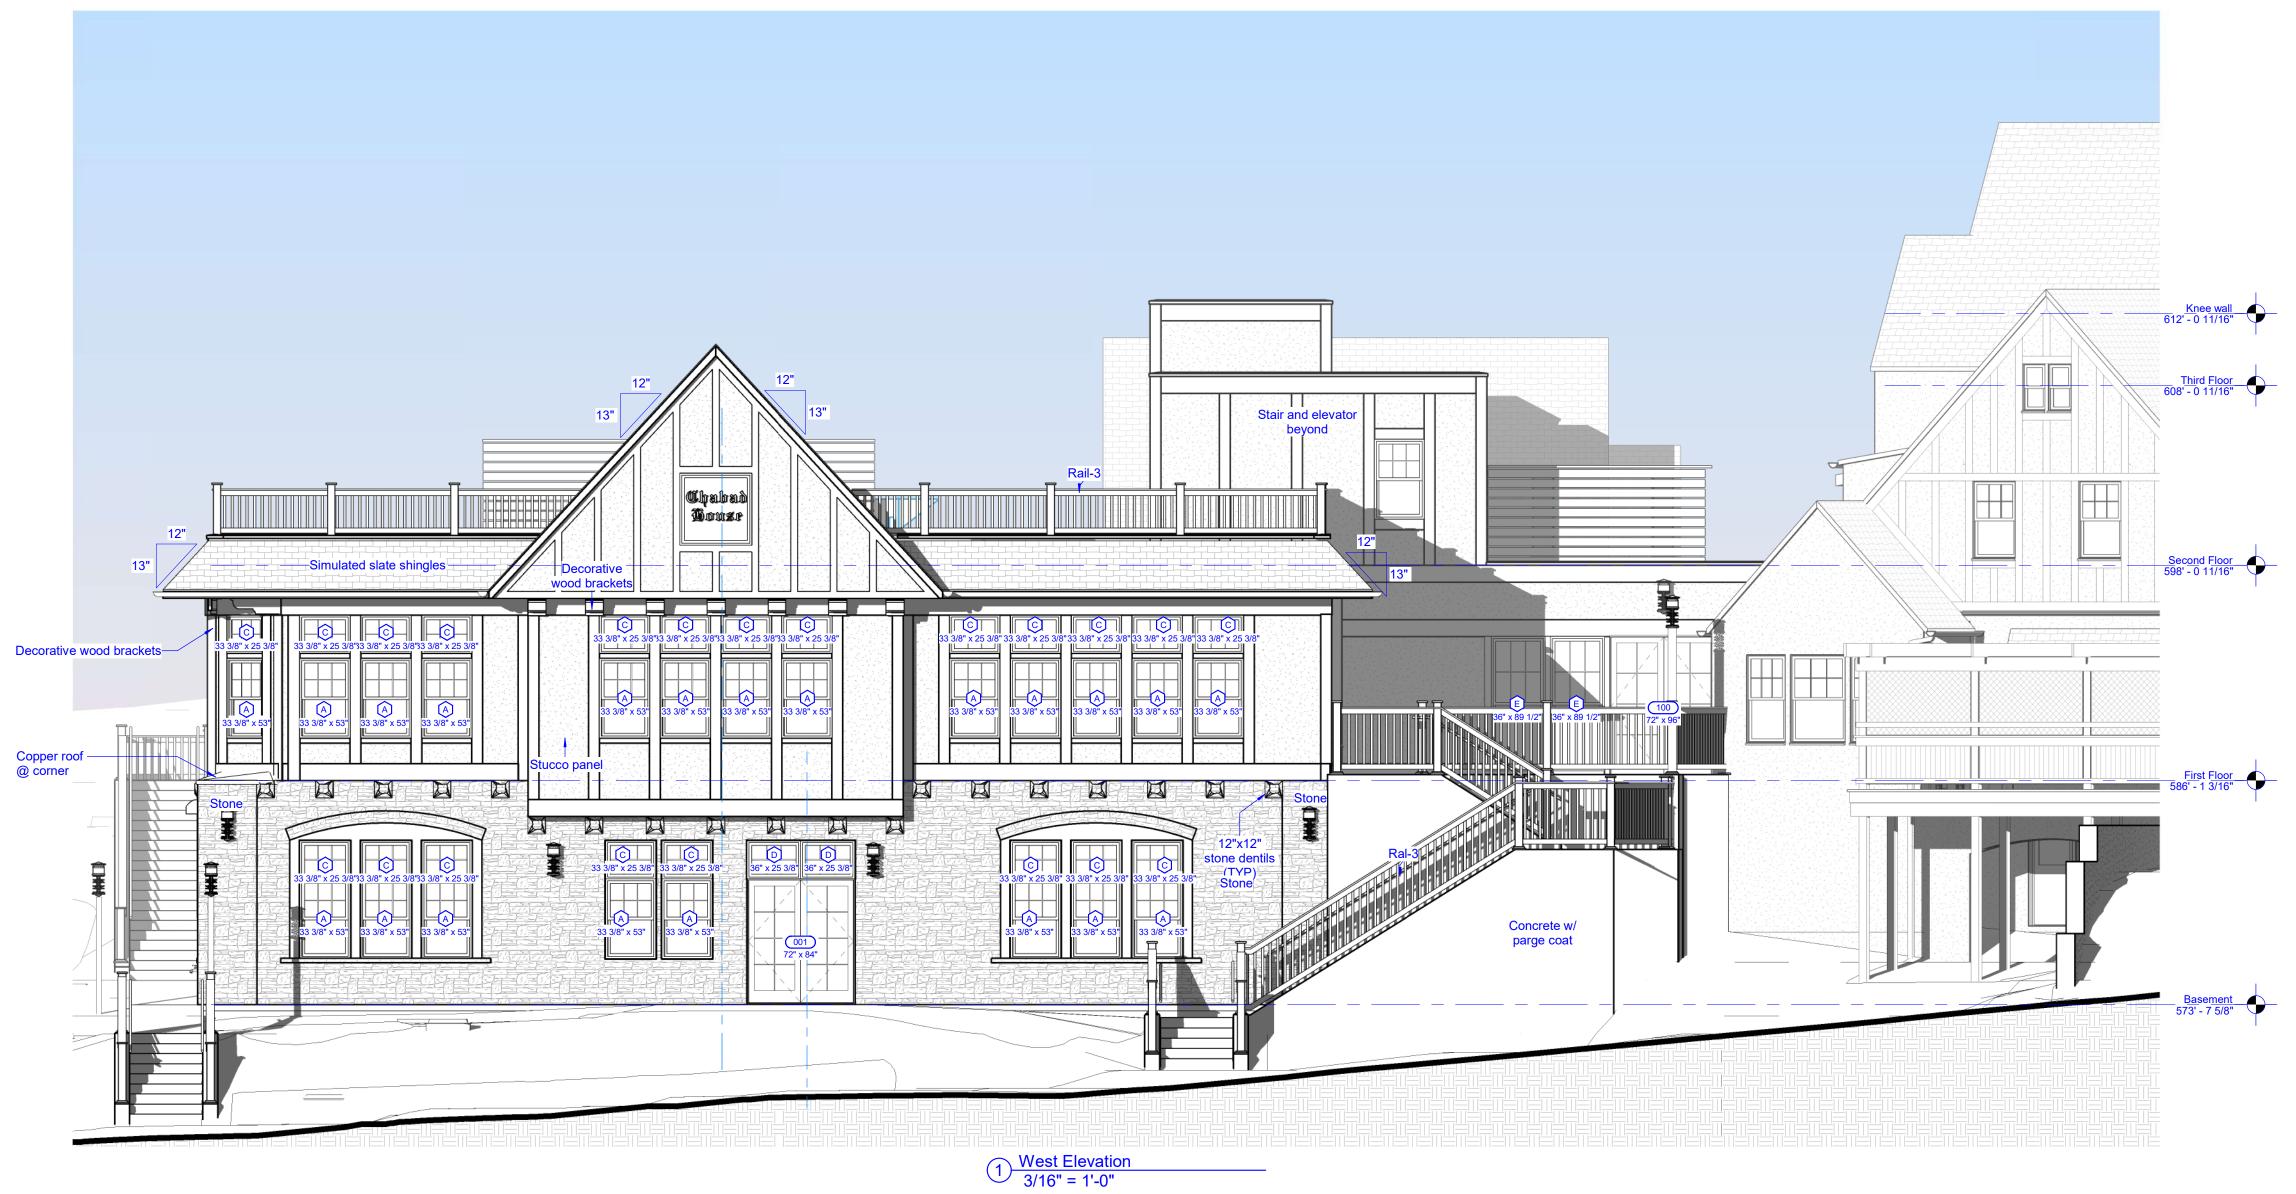

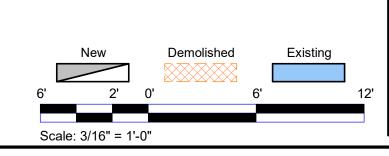

Chabad Center of Ithaca

Chabad Center of Ithaca

Chabad Center Expansion

Chabad Center of Ithaca

Chabad Center of Itha

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Revision Schedule


Number Description Date

Exterior Elevations

Project No: CHAB03
Date: 06/19/23
Drawn by: BAD
Checked by: JKD

A2.00

3/16" = 1'-0"

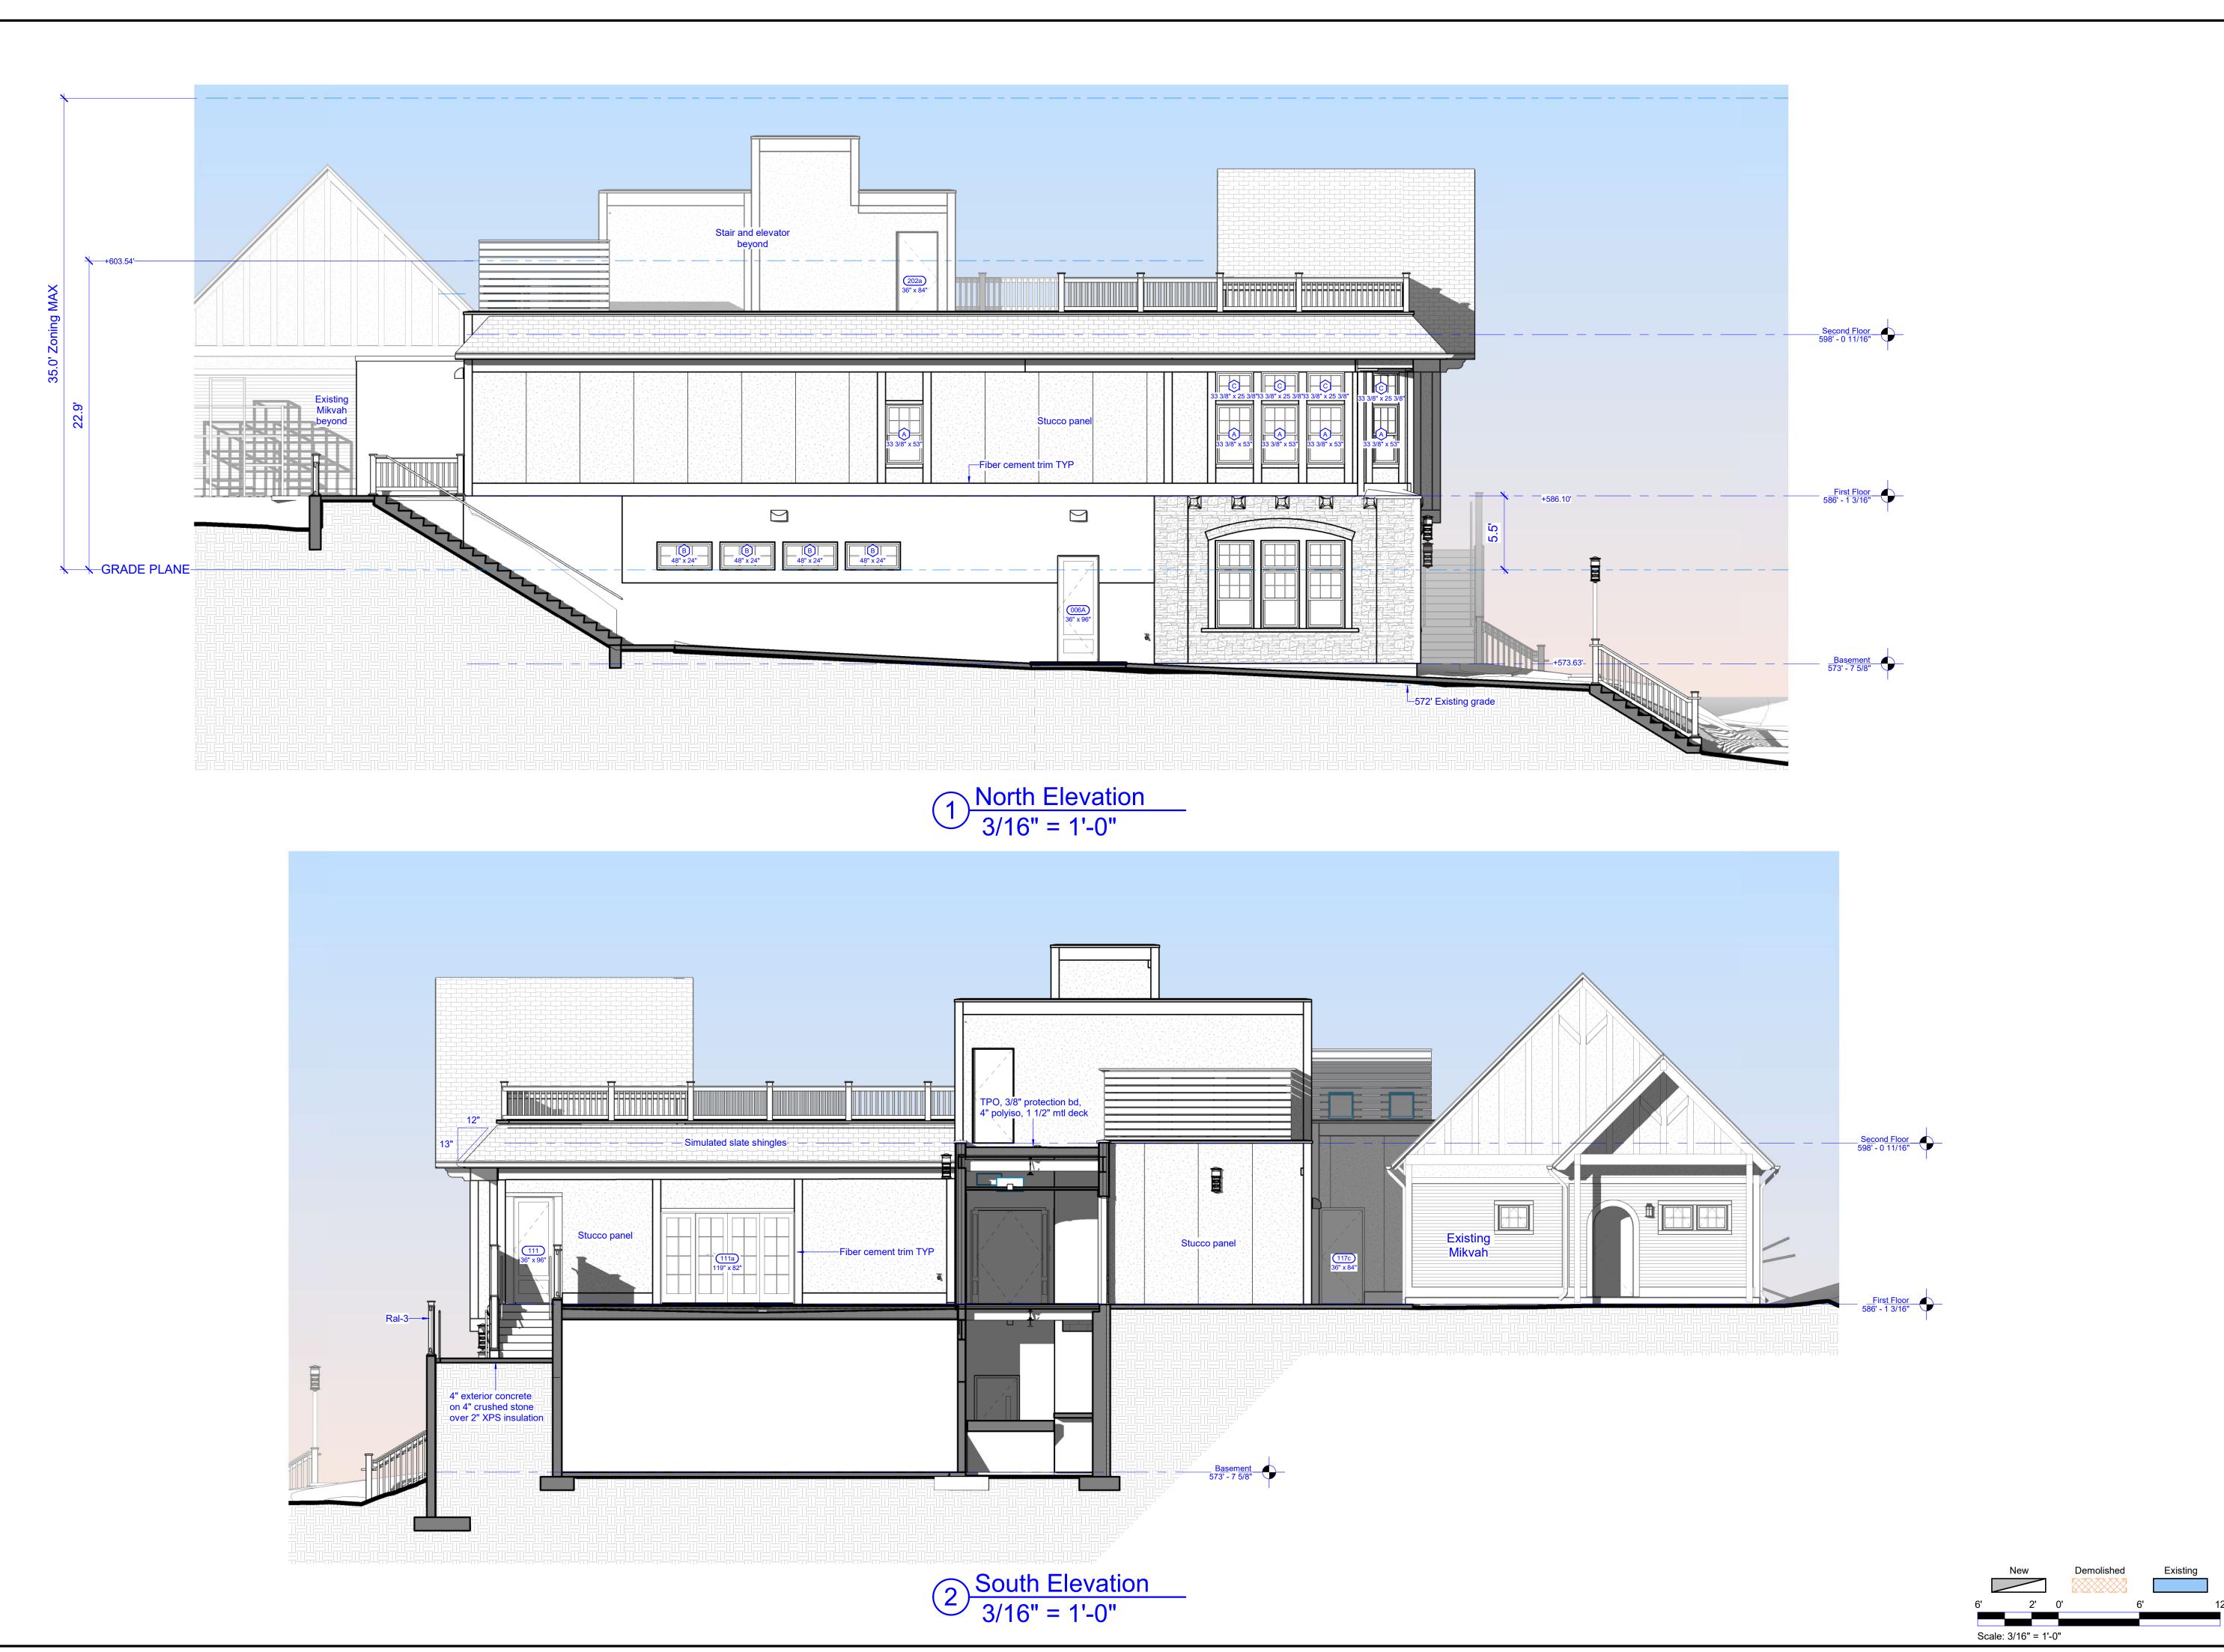

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Ithaca, New York 14850
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Chabad Center of Ithaca

Chabad Center of Ithaca

Chabad Center Expansion

102 Willard Way
Ithaca, NY 14850

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Exterior Elevations

Project No: CHAB03
Date: 06/19/23
Drawn by: BAD
Checked by: JKD

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3/16" = 1'-0"